


NOTES:


1. THIS DRAWING TO BE READ IN CONJUNCTION WITH ALL OTHER DRAWINGS AND SPECIFICATIONS.
2. DO NOT SCALE THE DRAWING
3. COLUMN TO REINFORCEMENT TO BE AS COLUMN -
4. CONCRETE TO BE GRADE-C23/40
5. STEEL BRACE-S208
6. TYPE 2 FORTIFIED BARS
7. MINIMUM LAP LENGTH SHOULD BE AS FOLLOWS
8. SCHEDULE
9. ALL REINFORCEMENT DETAILED ON THIS IS SUBJECT TO BS 8133 PART 1
10. REBAR CALL UP
11. REBAR - 22mm
12. REBAR - 16mm
13. REBAR - 12mm
14. REBAR - 10mm
15. REBAR - 8mm
16. REBAR - 6mm
17. REBAR - 4mm
18. REBAR - 3mm
19. REBAR - 2mm
20. REBAR - 1mm

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7. REBAR - 8mm
8. REBAR - 6mm
9. REBAR - 4mm
10. REBAR - 3mm
11. REBAR - 2mm
12. REBAR - 1mm

ANNOTATION OF LAYER






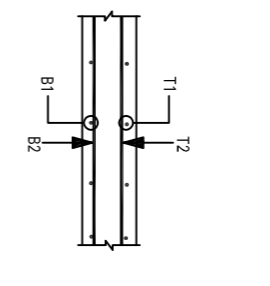


KEY PLAN

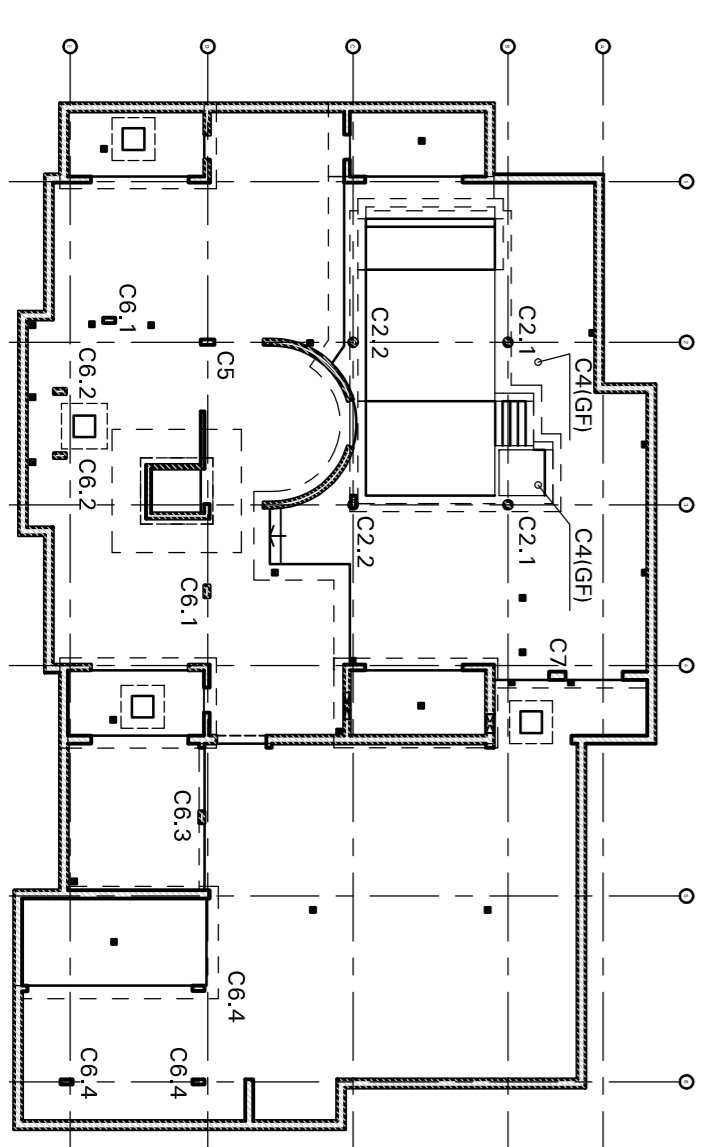

Scale	1:25	1:25	1:25
Drawn By	2012 SCNO	Checked By	2012 SCNO
Revised	5236	Revised	5236
Project No.	5236	Project No.	5236
Date	2012	Date	2012
Scale	1:25	Scale	1:25
Project No.	5236	Project No.	5236
Date	2012	Date	2012
Scale	1:25	Scale	1:25

FOR COLUMN STARTER BARS REFER TO DWG. 5236/R210

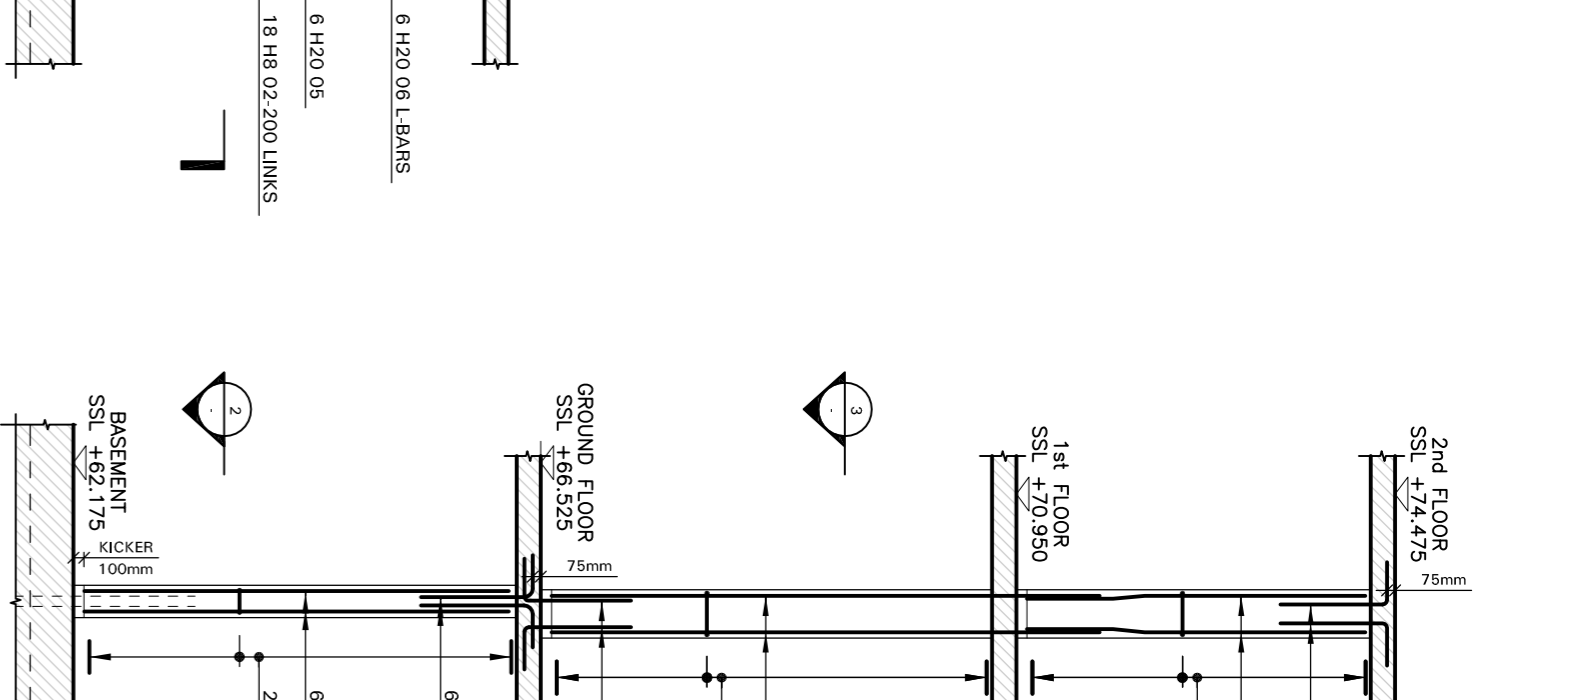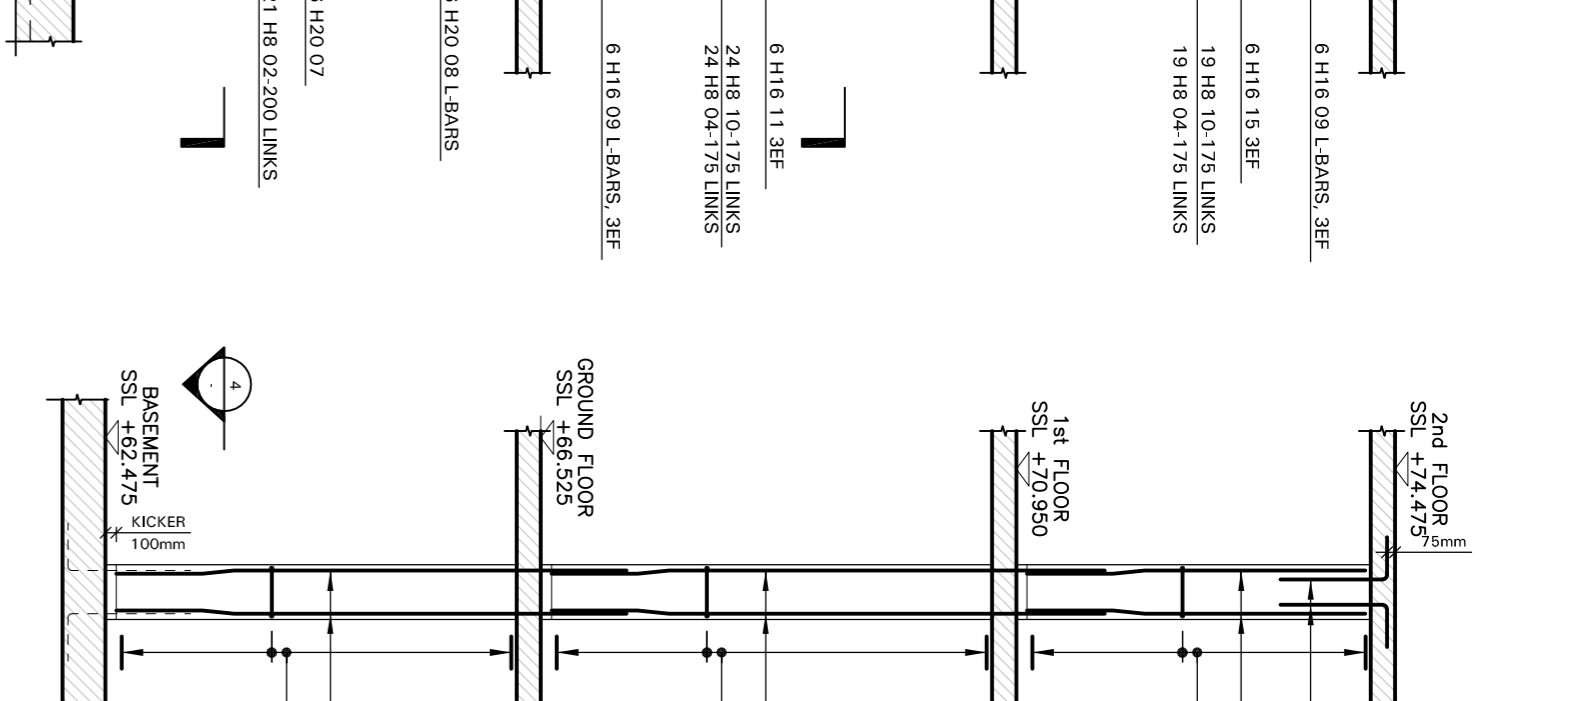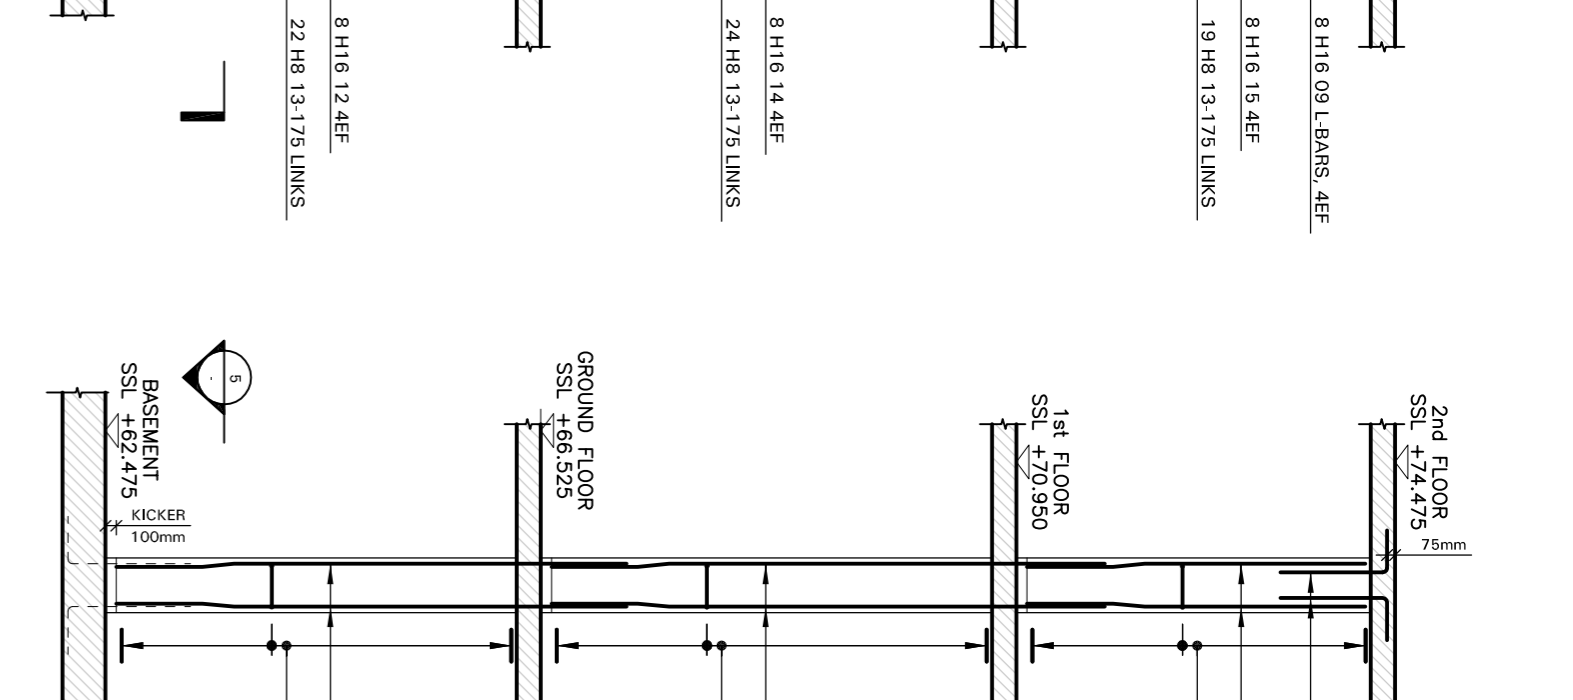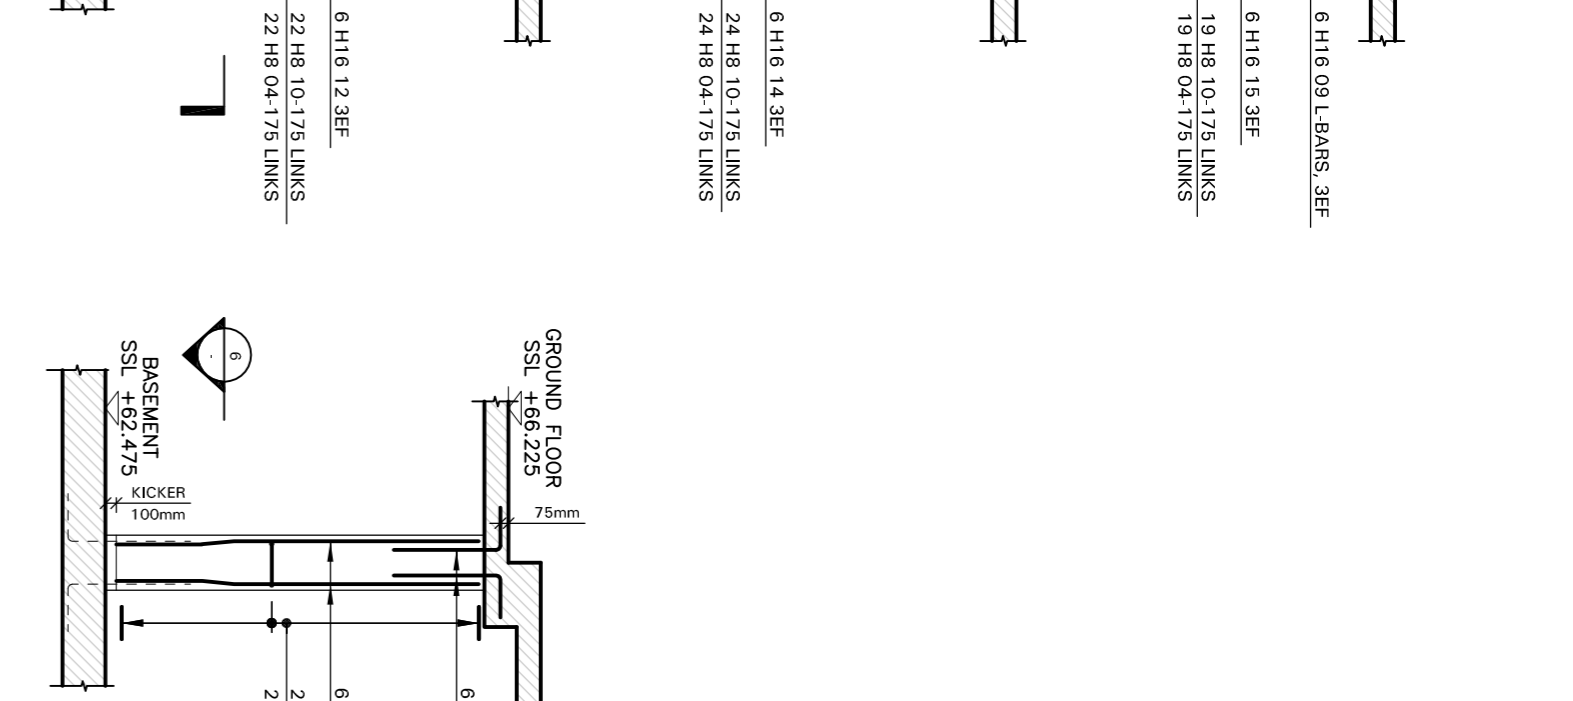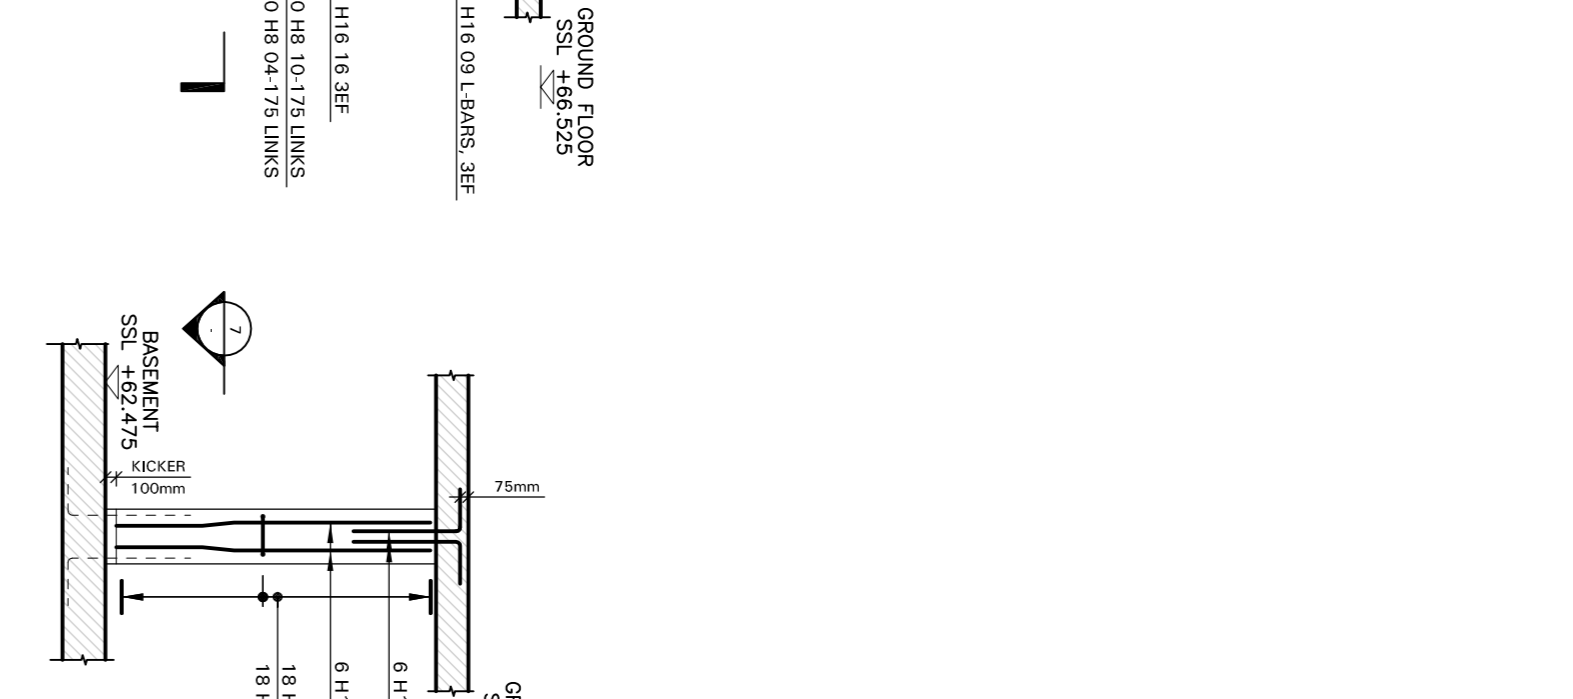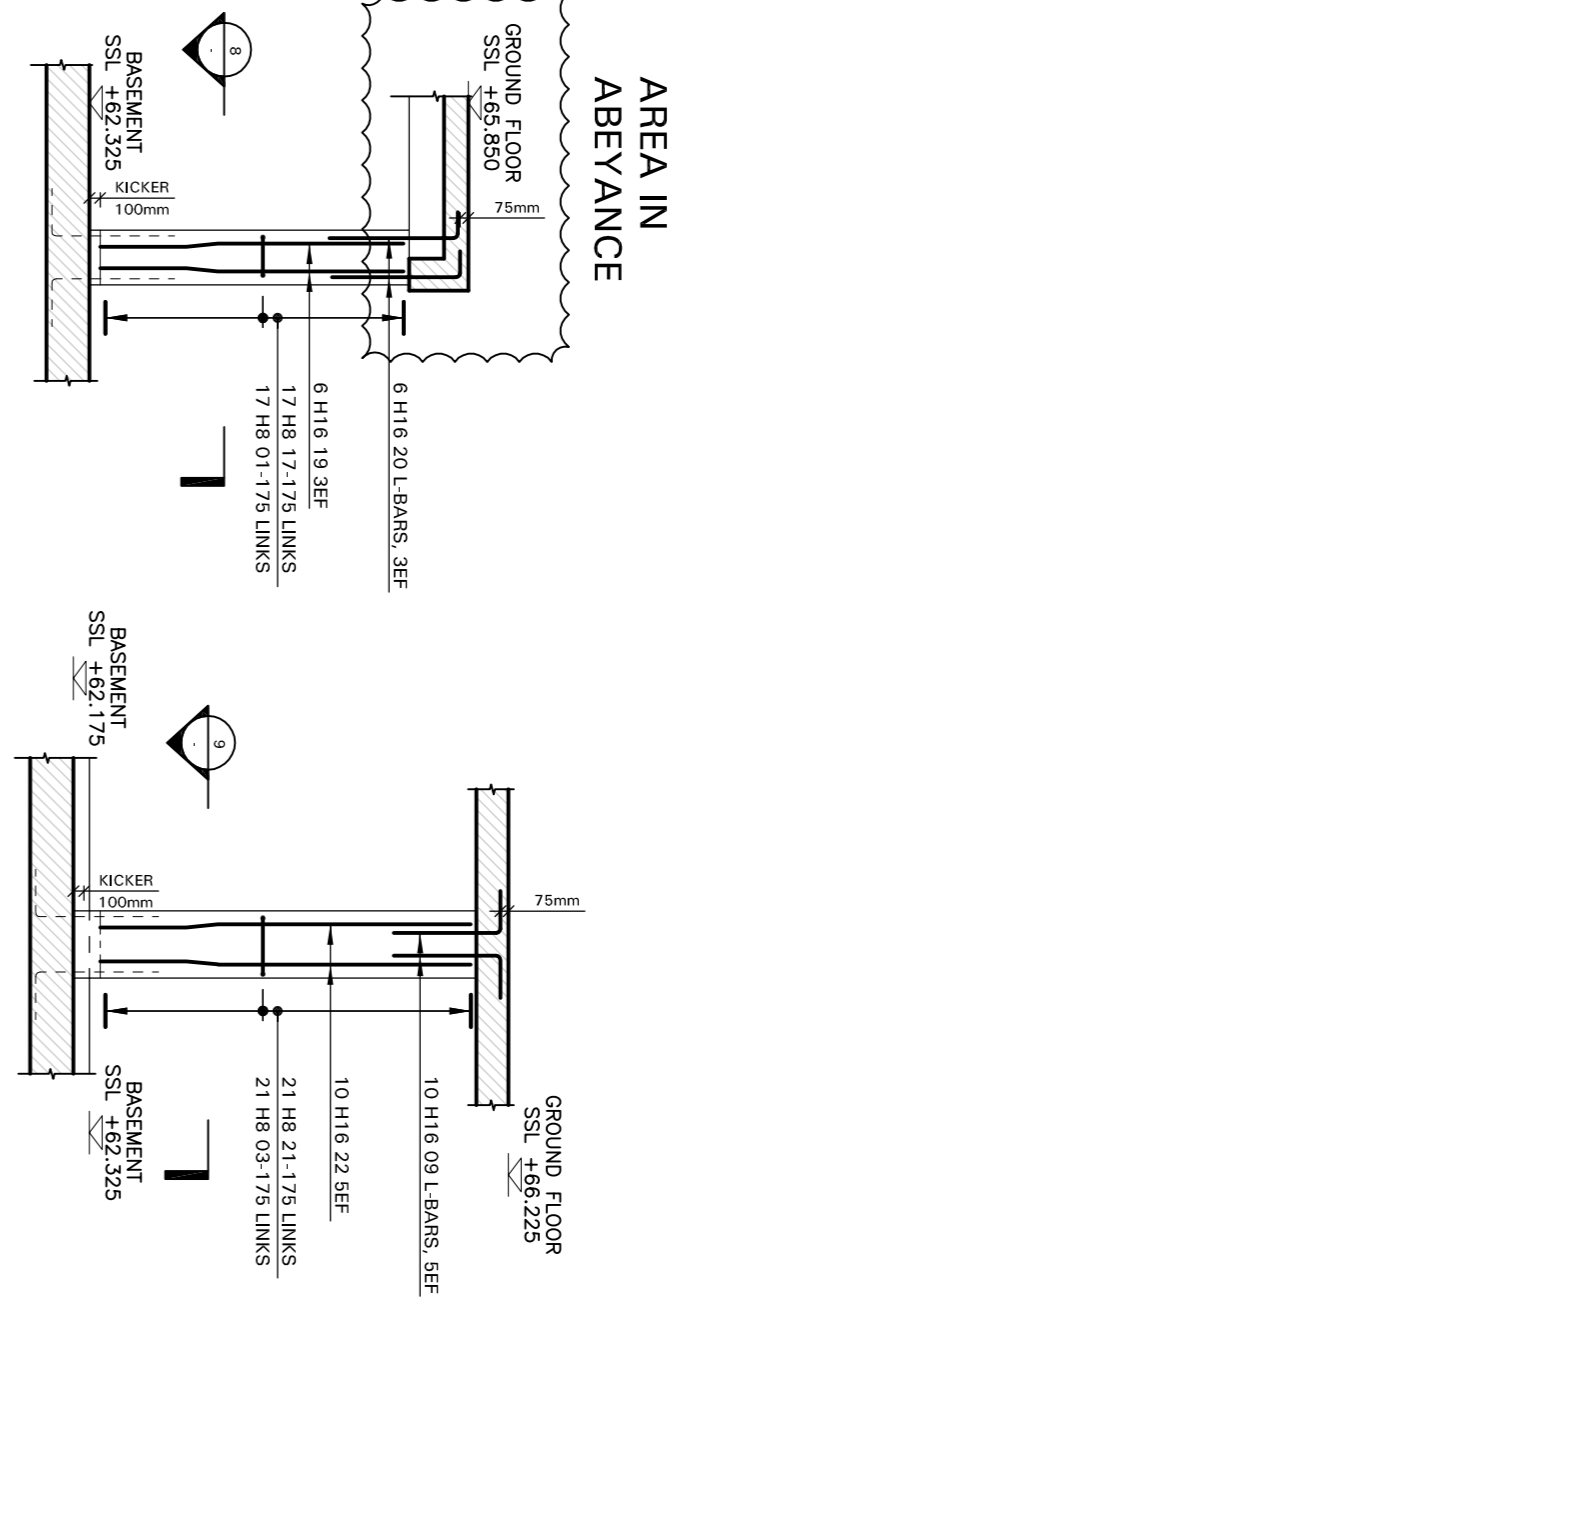

COLUMN TYPE C6.4
(3 No. THUS)
SCALE 1:30

COLUMN TYPE C6.3
(1 No. THUS)
SCALE 1:30

COLUMN TYPE C6.2
(2 No. THUS)
SCALE 1:30

COLUMN TYPE C6.1
(2 No. THUS)
SCALE 1:30

COLUMN TYPE C5
(1 No. THUS)
SCALE 1:30

COLUMN TYPE C2.2
(2 No. THUS)
SCALE 1:30

COLUMN TYPE C2.1
(2 No. THUS)
SCALE 1:30

COLUMN TYPE C4
(2 No. THUS)
SCALE 1:30

CROSS SECTION 1
SCALE 1:25

CROSS SECTION 2
SCALE 1:25

CROSS SECTION 3
SCALE 1:25

CROSS SECTION 4
SCALE 1:25

CROSS SECTION 5
SCALE 1:25

CROSS SECTION 6
SCALE 1:25

CROSS SECTION 7
SCALE 1:25

CROSS SECTION 8
SCALE 1:25

CROSS SECTION 9
SCALE 1:25

CROSS SECTION 10
SCALE 1:25